
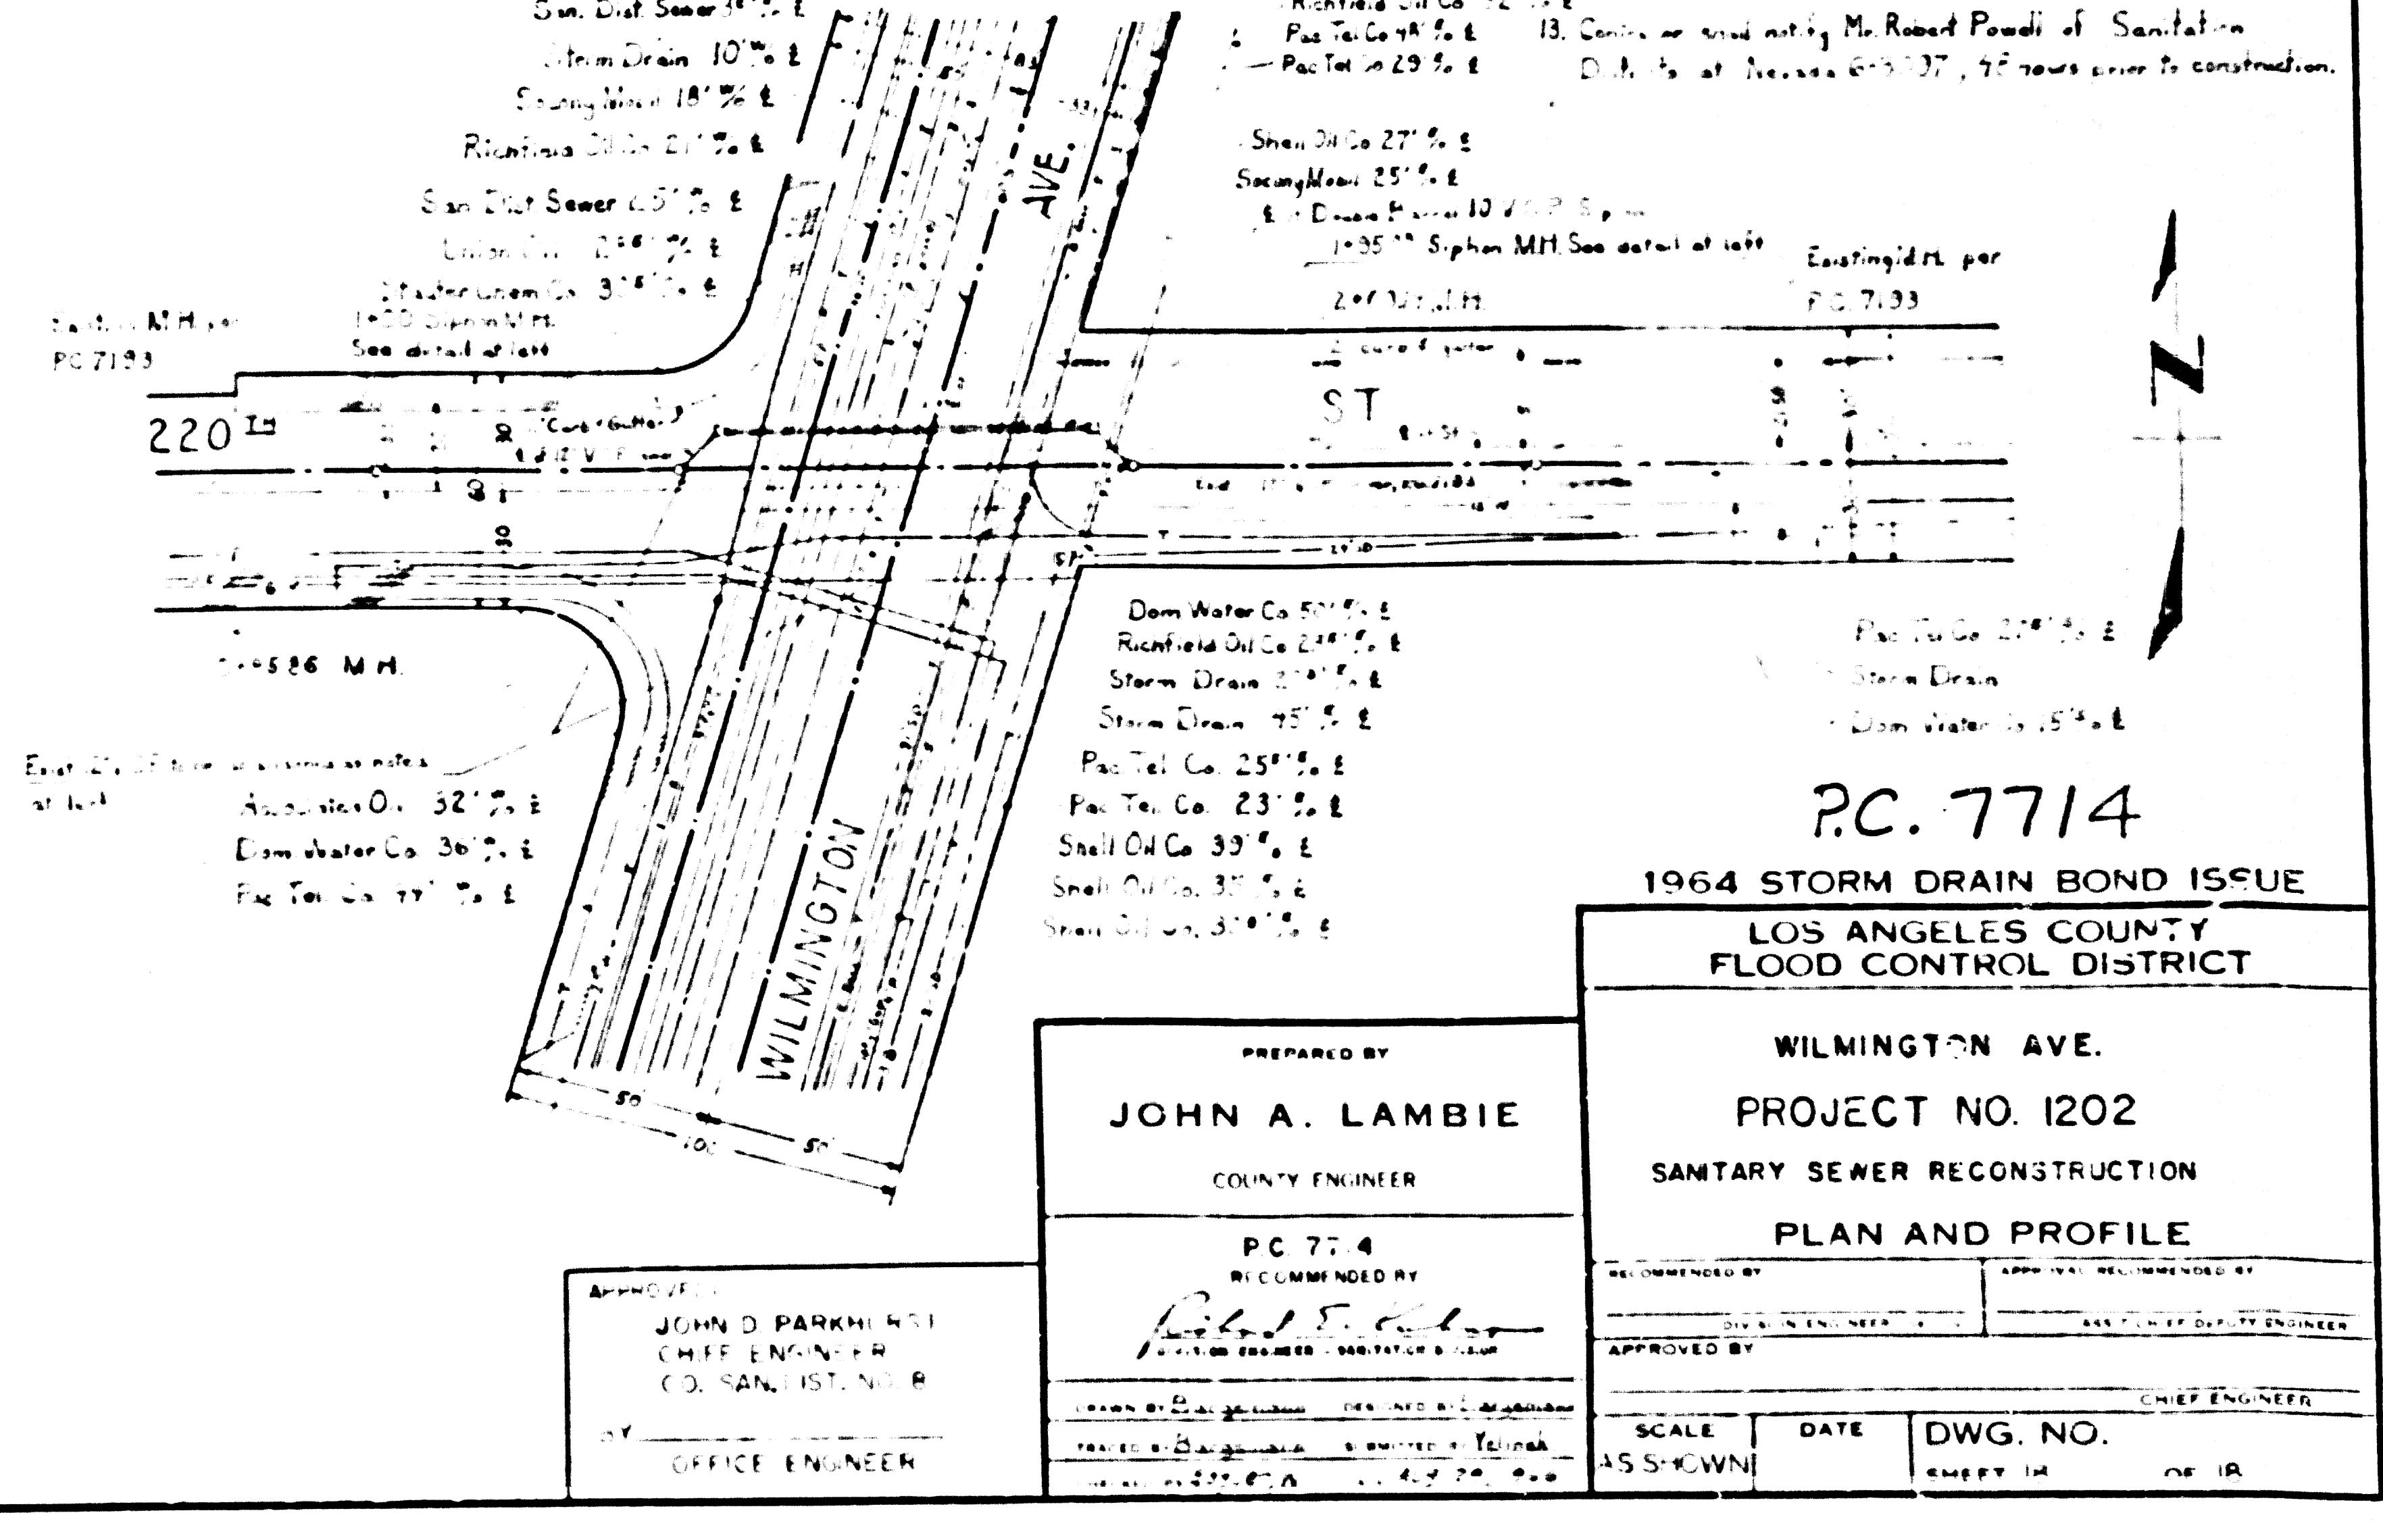
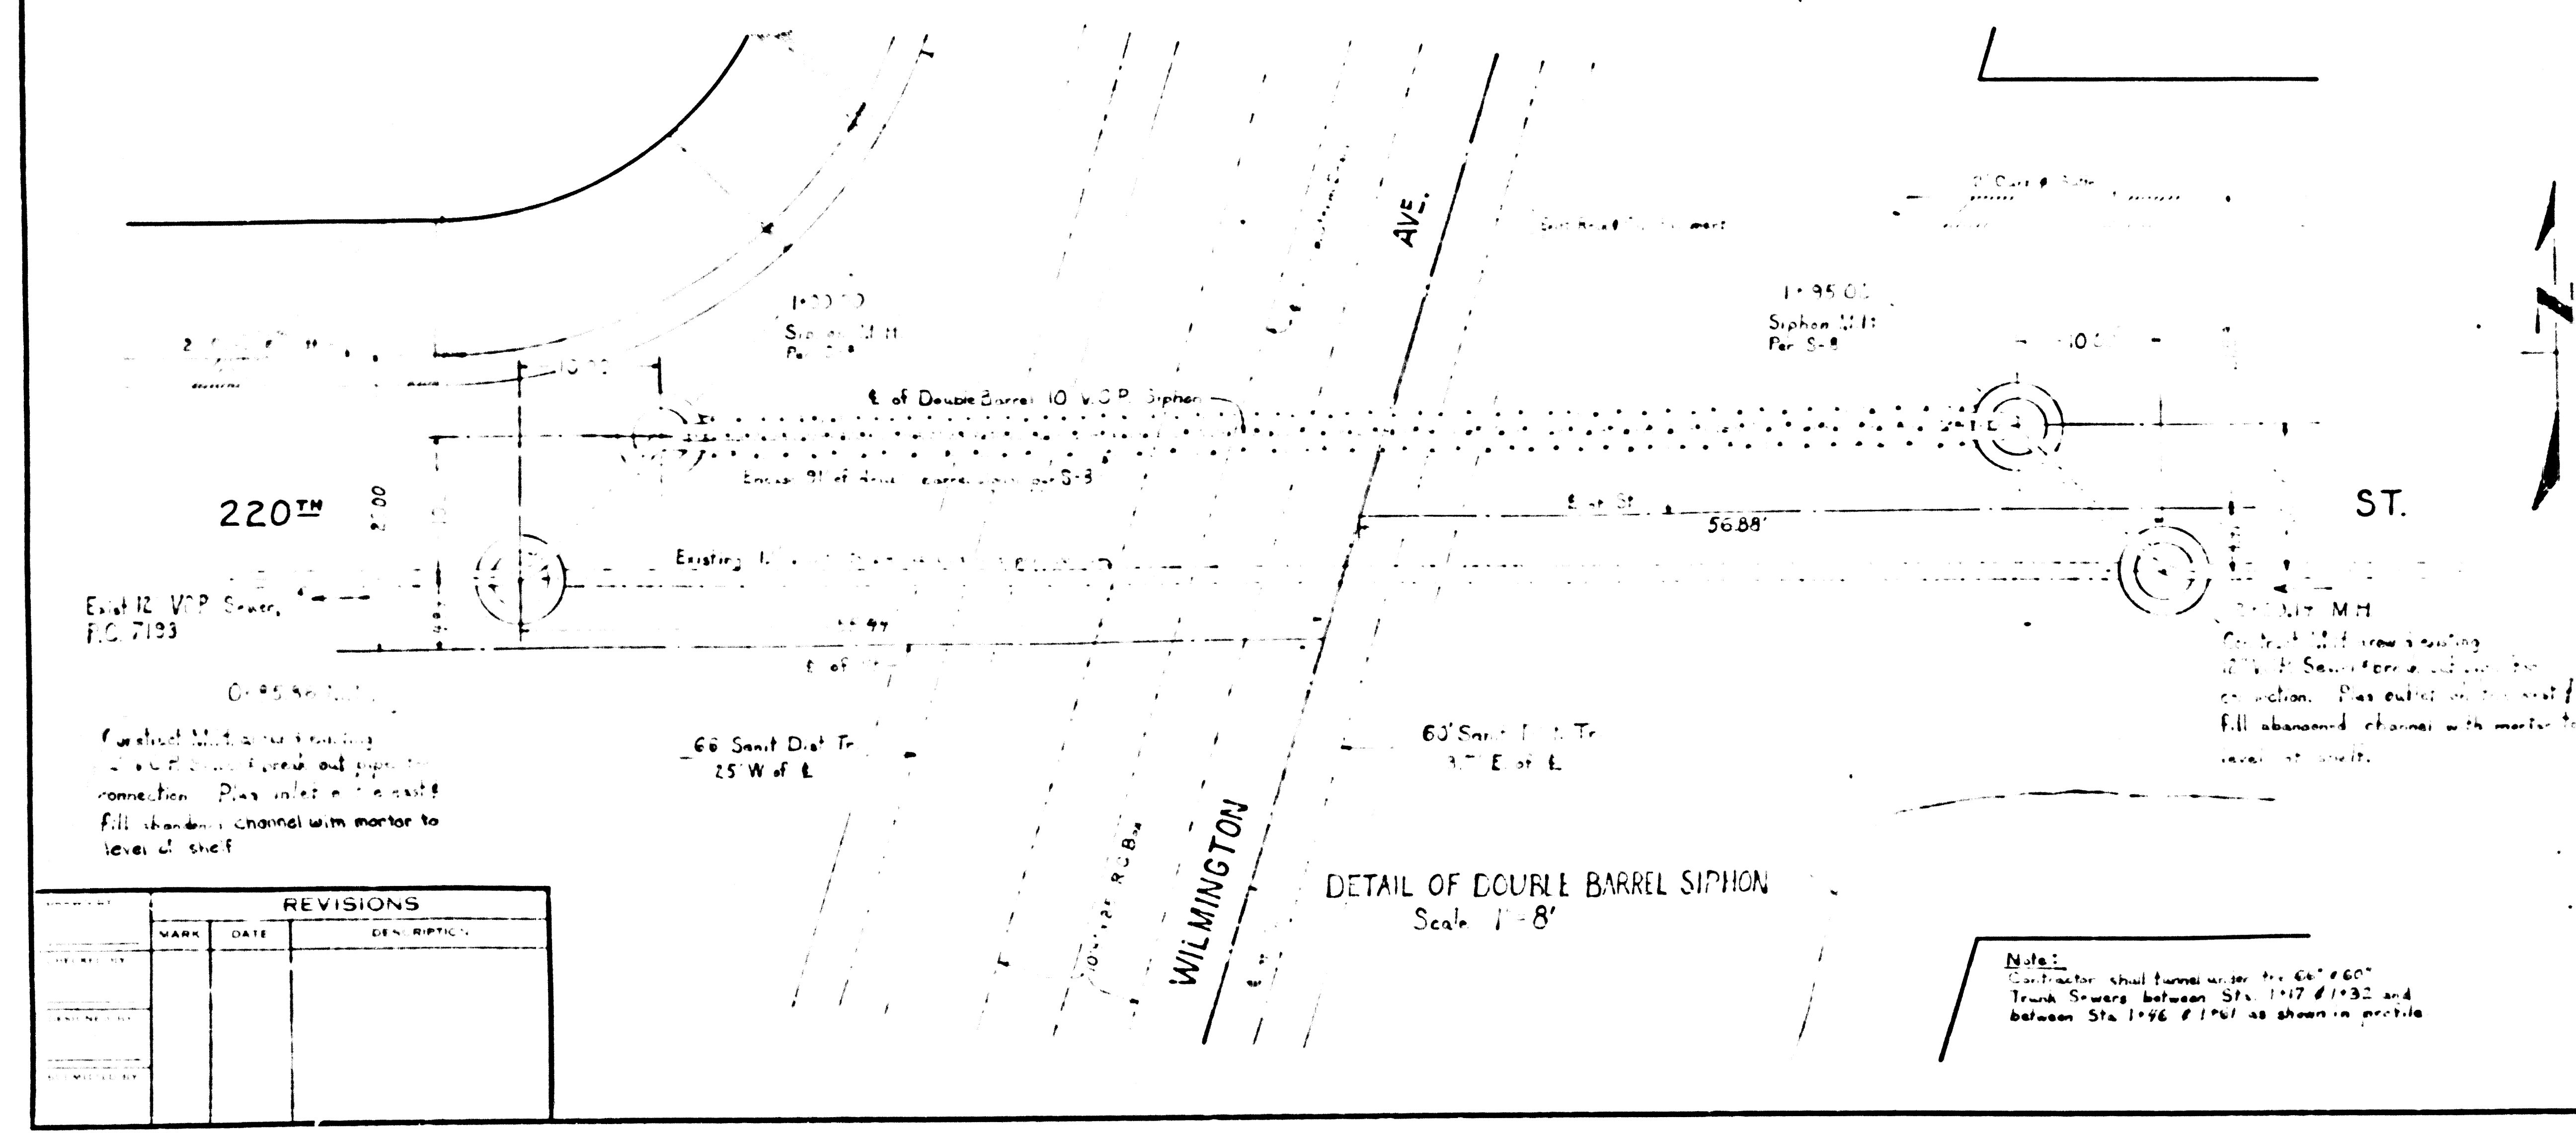


39686

GENERAL NOTES

1. For legend see standard plan S-1.
2. Use water depth minimum pipe.
3. Use maximum penetration joints for all vitrified clay pipe (except pipe sections).
4. All structures shall be built over structures as per standards plan S-1, except where noted.
5. Use standard manhole frames and covers per standard plan S-1.
6. The contractor shall be responsible for the location of existing structures and shall mark them with iron pins.
7. Use formula No. 2, Section 14 of Standard Sewer Specifications for allowable leakage.
8. Flow to be maintained at all times.
9. Resurface trenches within paved areas of streets as noted on storm drain plans.
10. Abandonment of existing sewers shall be done in accordance with Section 10 of the Standard Sewer Specifications.
11. Sanitary sewers shall be constructed according to standard Specifications for the Construction of Sewing Sewers as revised October, May 25, 1932, on file in the office of the County Engineer, and shall be placed in the ground in the presence of the County Engineer.
12. Approval of the plan for this project by the County of Los Angeles does not constitute a representation as to the accuracy of the location or the existence or maintenance of any existing utility pipe or structure within the limits of this project.
13. Contractor shall notify Mr. Reed Peadar of Sanitation District No. 1 at address 651-137, 92 years prior to construction.

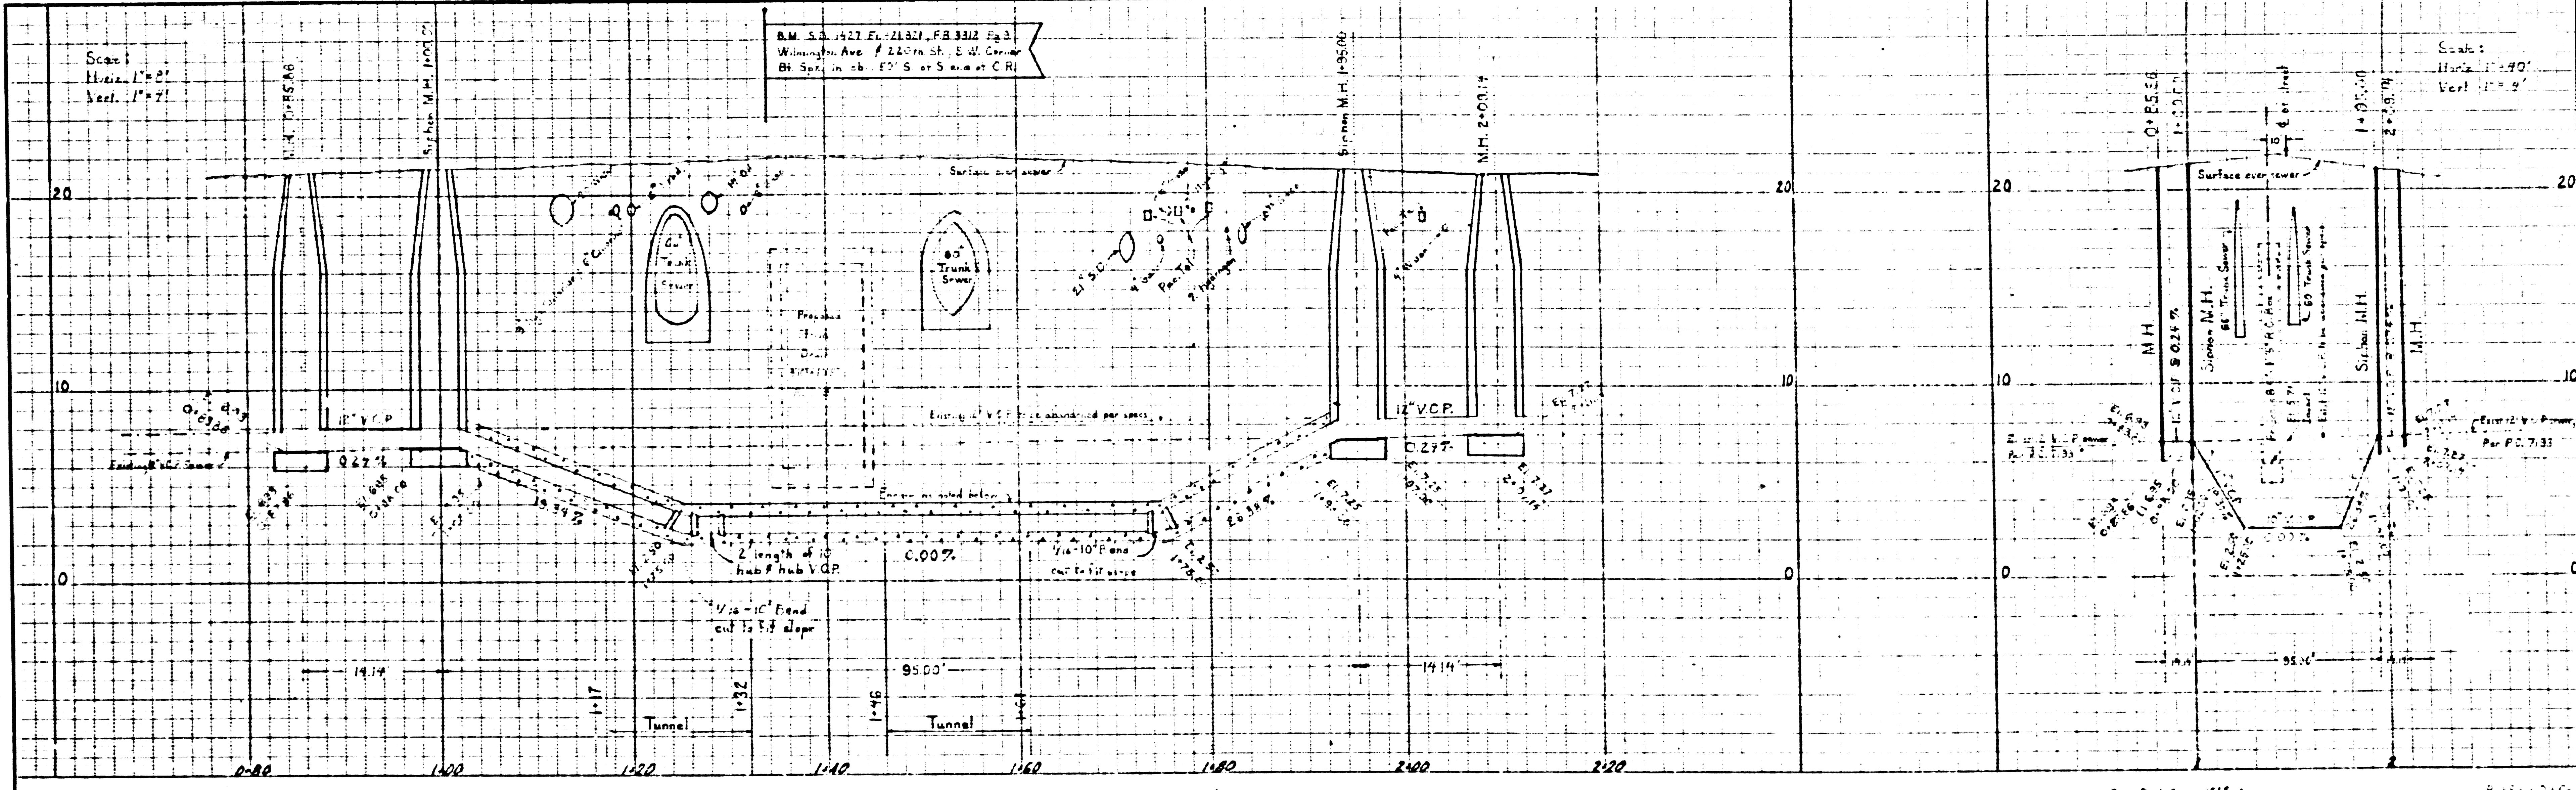

REVISIONS		
NO.	DATE	DESCRIPTION

PREPARED BY
JOHN A. LAMBIE
COUNTY ENGINEER

APPROVED BY
John D. Parkhill
JOHN D. PARKHILL
CHIEF ENGINEER
LOS ANGELES COUNTY SANITATION DISTRICT NO. 1

1964 STORM DRAIN BOND ISSUE
LOS ANGELES COUNTY
FLOOD CONTROL DISTRICT

WILMINGTON AVE.
PROJECT NO. 1202
SANTARY SEWER RECONSTRUCTION
PLAN AND PROFILE

SCALE: AS SHOWN
DATE: _____
DWG. NO.: _____