

- GENERAL NOTES SEWERS**
1. FOR LEGEND SEE STANDARD PLAN S-1.
 2. USE EXTRA STRENGTH VITRIFIED CLAY PIPE.
 3. USE MECHANICAL COMPRESSION JOINTS FOR ALL VITRIFIED CLAY PIPE SEWERS PER SEC. 56, 44149 OF STANDARD SPECIFICATIONS, AS REVISED.
 4. ALL STRUCTURES SHALL BE BRICK SEWER STRUCTURES AS PER PLAN NO. S-3.
 5. USE STANDARD MANHOLE FRAMES AND COVERS AS PER PLAN NO. S-15.
 6. USE FORMULA NO. 2, SEC. 54 OF SPECIFICATIONS TO COMPUTE ALLOWABLE LEAKAGE.
 7. REFURFACE TRENCHES WITHIN THE PAVED AREA OF STREETS PER SEC. 69 OF SPECS.
 8. ABANDONED PORTIONS OF MAIN LINE SEWERS OR HOUSE LATERALS SHALL BE SEALED PER SEC. 69 OF SPECS.
 9. SANITARY SEWERS SHALL BE CONSTRUCTED ACCORDING TO STANDARD PRACTICE, SHOWN HEREON, PER SEC. 54, 44149 OF STANDARD SPECIFICATIONS, AS REVISED. ALL WORK SHALL BE PROSECUTED ONLY IN THE PRESENCE OF THE COUNTY ENGINEER AND SANITATION DISTRICT REPRESENTATIVE FOR WORK TO BE DONE ON OR IN THE VICINITY OF SANITATION DISTRICT FACILITIES.
 10. THE CONTRACTOR SHALL NOTIFY THE CONSTRUCTION DIVISION BY TELEPHONE MA 9-4747 EXT. 81551 AT LEAST 24 HOURS BEFORE STARTING ANY WORK UNDER THIS PROJECT.
 11. APPROVAL OF THE SEWER PLANS FOR THIS PROJECT BY THE COUNTY OF LOS ANGELES DOES NOT CONSTITUTE A REPRESENTATION AS TO THE ACCURACY OF THE LOCATION OR DEPTH OF THE EXISTENCE OR NON-EXISTENCE OF ANY UNDERGROUND UTILITY PIPE, OR STRUCTURE WITHIN THE LIMITS OF THIS PROJECT.
 12. NO REVISIONS SHALL BE MADE IN THESE PLANS WITHOUT THE APPROVAL OF THE COUNTY ENGINEER.
 13. FLOW IN EXISTING SERVICES MUST BE MAINTAINED AT ALL TIMES DURING CONSTRUCTION.

BEFORE MAKING UP INTO ANY EXISTING STRUCTURE AND BEFORE FINAL ACCEPTANCE OF THIS WORK, COUNTY SANITATION DISTRICT (DU 41281) SHALL BE NOTIFIED IN ORDER THAT REQUIRED INSPECTION CAN BE MADE.

1964 STORM DRAIN BOND ISSUE
LOS ANGELES COUNTY
FLOOD CONTROL DISTRICT

PREPARED BY
JOHN A. LAMBIE
COUNTY ENGINEER

REGIONAL
PROJECT NO. 1106
UNIT 2
SANITARY SEWER RECONSTRUCTION

APPROVED: **JOHN D. PARKLURST**
CHIEF ENGINEER
CO. SAN. DIST. #2

RECOMMENDED BY
PC 7645
DIVISION ENGINEER

DRAWN BY: **M. ESQUER**
CHECKED BY: **M. ESQUER**
DATE: **JULY 1964**

SCALE: AS SHOWN
DATE: SHEET 18 OF 20
DWG. NO. 364-1106-D1.18

REVISIONS			
MARK	DATE	DESCRIPTION	BY

PLAN
SCALE 1" = 40'

NOTE
Exist. 18" Trunk Sewer serves only that property southerly of Park St. (609 S1) and flow is to be maintained at all times.



NO CONNECTIONS FOR THE DISPOSAL OF INDUSTRIAL WASTES SHALL BE MADE TO SEWERS SHOWN ON THESE DRAWINGS WITHOUT WRITTEN PERMISSION FROM THE CHIEF ENGINEER AND GENERAL MANAGER OF THE COUNTY SANITATION DISTRICT.

PROFILE
 HORIZ. SCALE: 1" = 40'
 VERT. SCALE: 1" = 4'

40555

AM SD G/S B/L 40403 PA 9316-51
 DONOVAN W/2 E/4 65TH ST, BY B/L IN LOT
 IN CONC. CO. OF MAP 44-15-11-21 N 20th C.A.

"Ys" to be laid horizontal & exist house laterals extending easterly to be reconnected to new sewer per Standard Drawing 20-250, Case 5

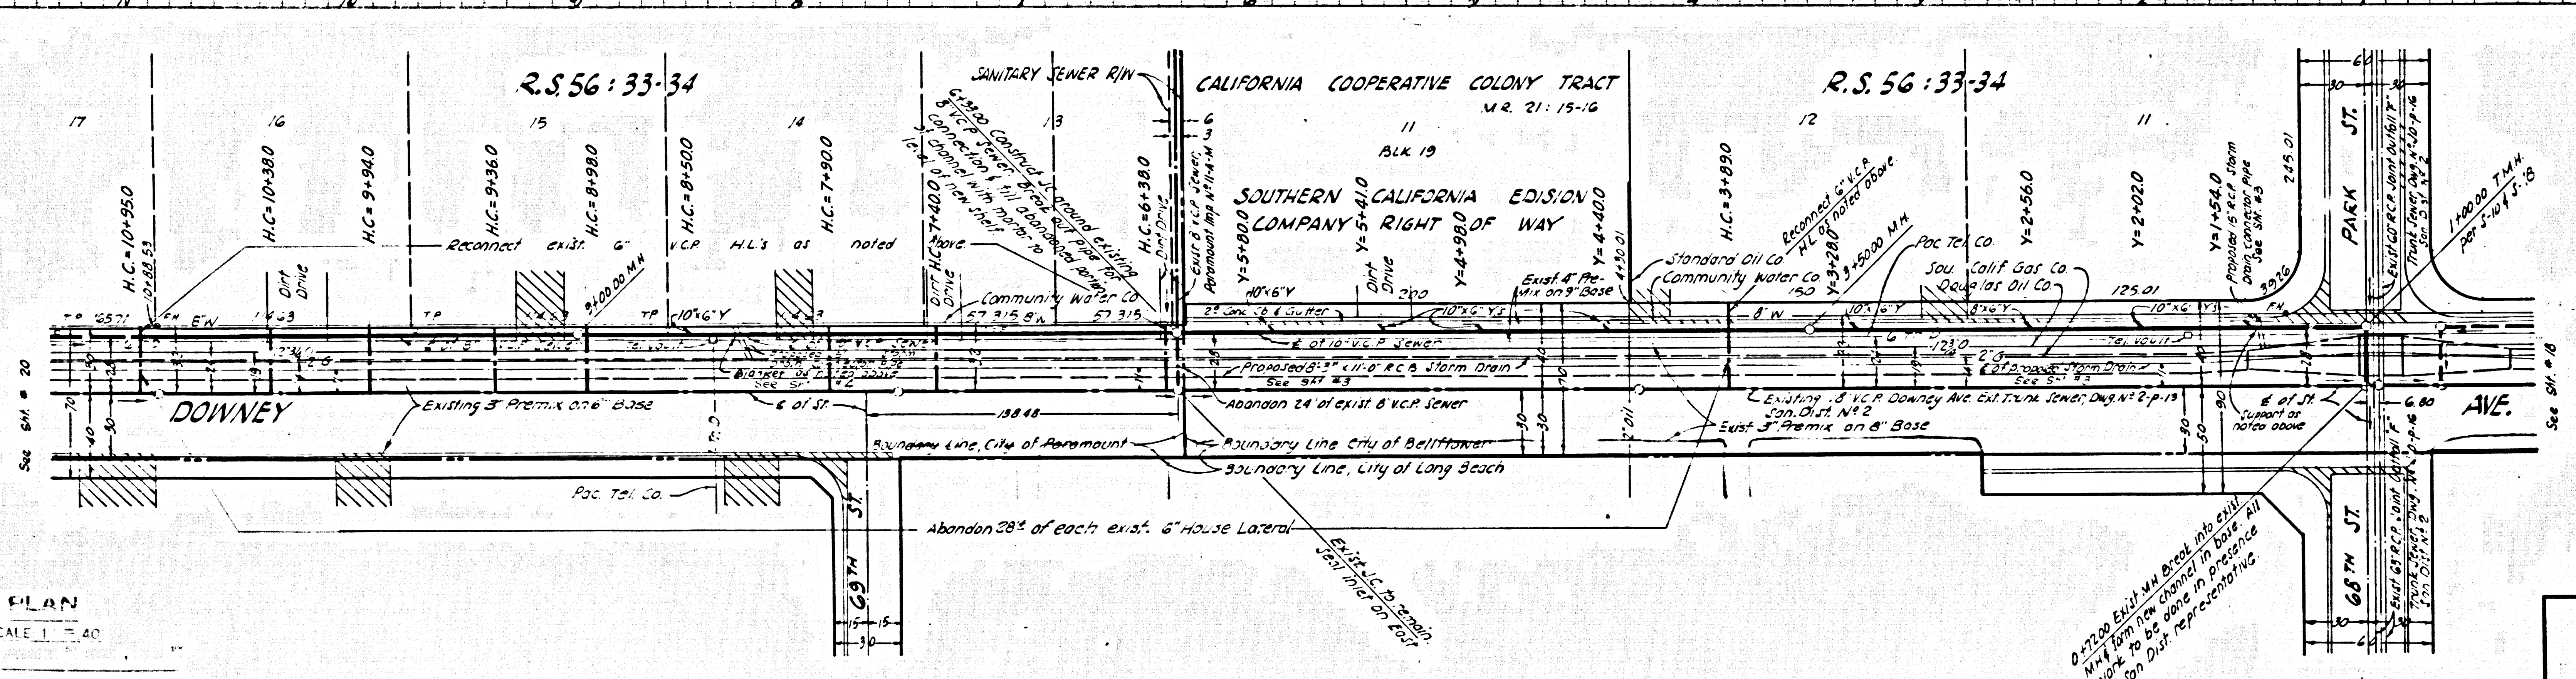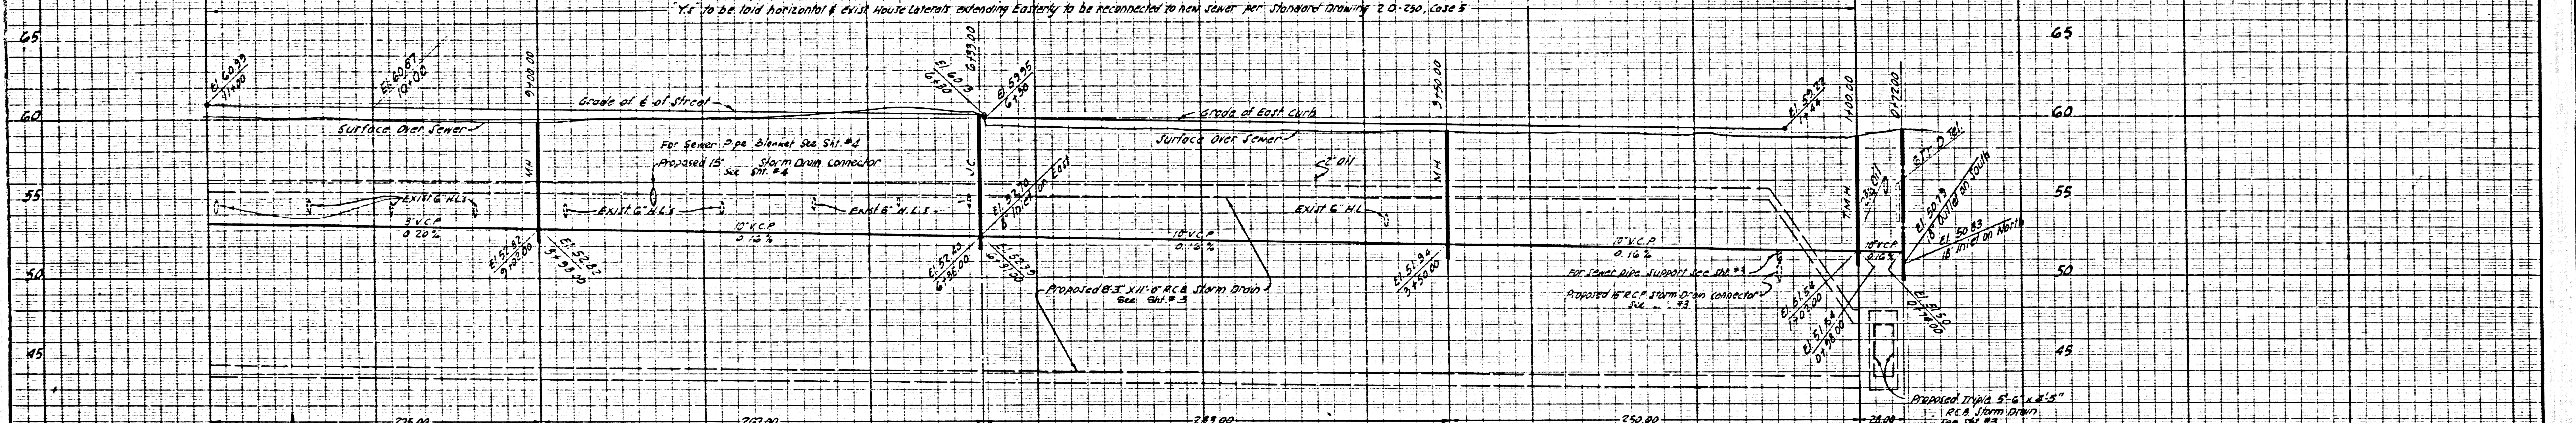

PLAN
 SCALE 1" = 40'

REVISIONS			
NO.	DATE	DESCRIPTION	BY

0.7500 EXISTING BASE TO NEW BASE. ALL
 WORK TO BE DONE IN PRESENCE
 OF SAN DIST REPRESENTATIVE

APPROVED: JOHN D. PARKHURST
 CHIEF ENGINEER
 CO SAN DIST # 2

BY: [Signature]
 OFFICE ENGINEER

PREPARED BY
 JOHN A. LAMBIE
 COUNTY ENGINEER

RC 7645
 SUBMITTED BY
 [Signature]
 DIVISION ENGR

DRAWN BY: B. ESKER
 TRACED BY: B. ESKER

1964 STORM DRAIN BOND ISSUE
 LOS ANGELES COUNTY
 FLOOD CONTROL DISTRICT

REGIONAL
 PROJECT NO. 1106
 UNIT 2
 SANITARY SEWER RECONSTRUCTION
 PLAN AND PROFILE

RECOMMENDED BY: [Signature]
 DIVISION ENGINEER (SEAL)

APPROVAL RECOMMENDED BY: [Signature]
 ASST. CHIEF DEPUTY ENGINEER

APPROVED BY: [Signature]
 CHIEF ENGINEER

SCALE: AS SHOWN
 DATE: Nov 16
 DWG. NO. 364-1106-D1.19
 SHEET 19 OF 20