

NOTES:

Elevations are in feet above U.S.S. or mean Sea Level Datum.

Elevations of all Lateral Inlets refer to the intersection of the invert of the Lateral with the inside face of the man drain or structure.

Stations of all Connector Pipe Inlets refer to the intersection of the center line of the connector pipe with the inside face of the man drain or structure. Bring connector pipes in routinely to pipe drains where structures are not designated.

Connector Pipes in Box Sections shall be laid in conjunction with Junction Structure #14 (Standard Dc-88), unless otherwise specified by the Engineer of Construction.

Connector Pipe with cover less than two feet shall be exposed according to Standard Dc-88.

All Pipe not otherwise specified shall be Standard Strength Cement Concrete Pipe.

For Structures marked SPEC STR #14 or SECTION--see structural details on Special Structures and Box Section Sheet.

All Structures not otherwise specified are Standard Structures. See details on Standard Plans.

Sanitary Sewers crossing over or with a clearance of 1.00 feet or less under Storm Drain, shall be constructed or reconstructed as shown on Standard Dc-36, except as otherwise specified on detail Sewer Plan.

LOMITA BOULEVARD DRAINAGE SYSTEM
 OF THE COUNTY OF LOS ANGELES CALIFORNIA
PLAN AND PROFILE OF
LOMITA TRUNK
250TH STREET BRANCH

SHEET 3A OF 8 SHEETS
 SCALE VERT. 1" = 4'
 HORIZ. 1" = 40'
 ALFRED W. COOK - COUNTY ENGINEER



THIS DRAWING AND THE DATA HEREON ARE HEREBY MADE A PART OF THE SPECIFICATIONS

P.R.	REFERENCE	DESIGNED	J.A. HARTLEY	OCT. 48
		TRACED	W.F. BRUSHNER	OCT. 48
		CHECKED	C.H. GREEN	OCT. 48

CSB-1165-3-A
 A1 OF A3

3A

SHEET NO. 3-A OF 8 SHEETS
 CONSULT SURVEYORS MAP NO. B-1183
 COUNTY OF LOS ANGELES
 DIVISION OF PUBLIC WORKS
 SHEET 2 & 3 TO A-C ON THESE

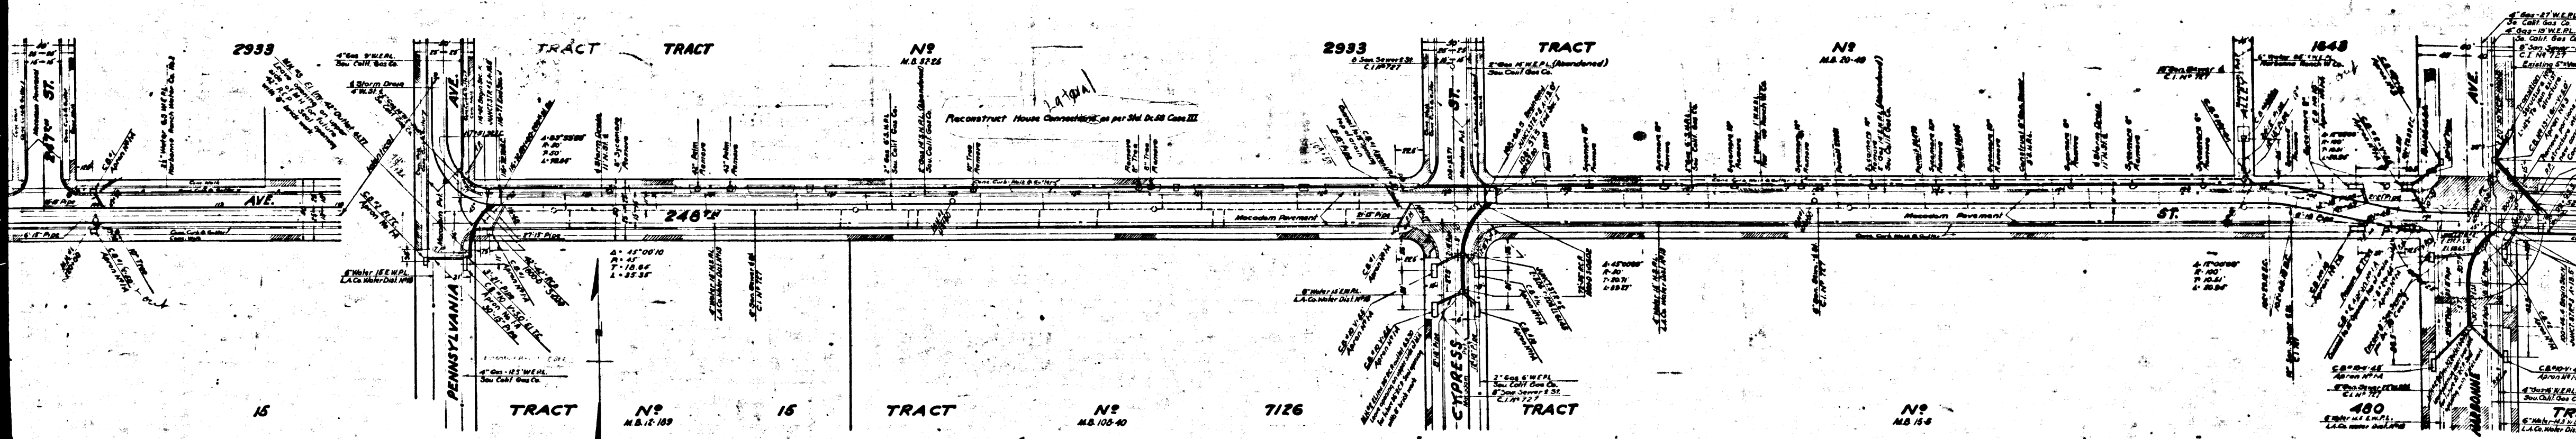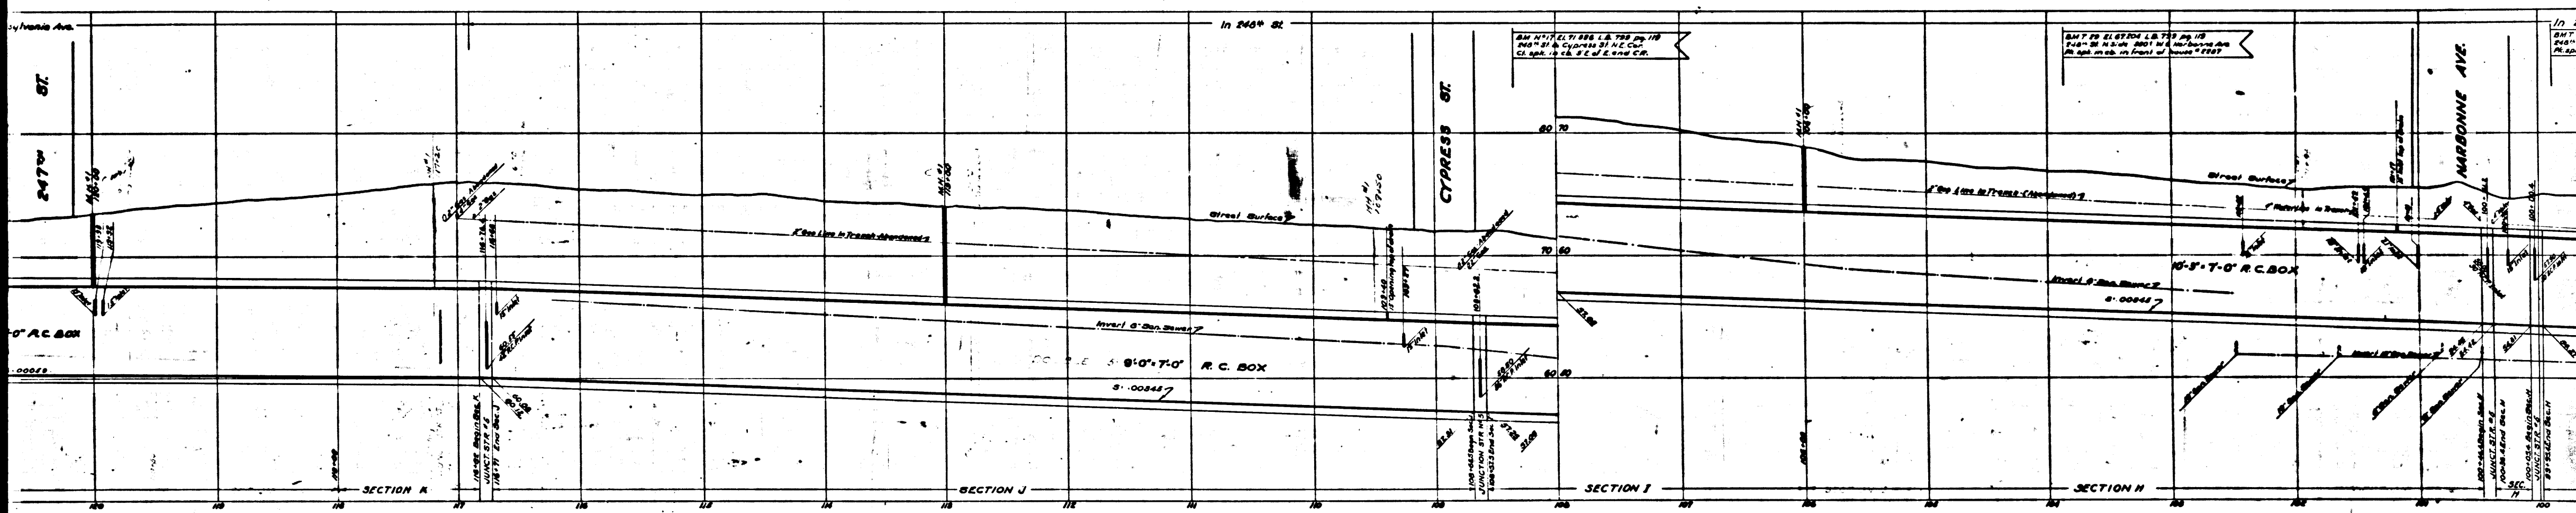



TRUNK

CSB-1165-3-A
A 2 OF A 3

LOMITA

SHEET NO. 3-Y OF 8 SHEETS
CONILLA SURVEYORS MAP NO. B-1182

SHEET NO. 3-Y OF 8 SHEETS
CONILLA SURVEYORS MAP NO. B-1182

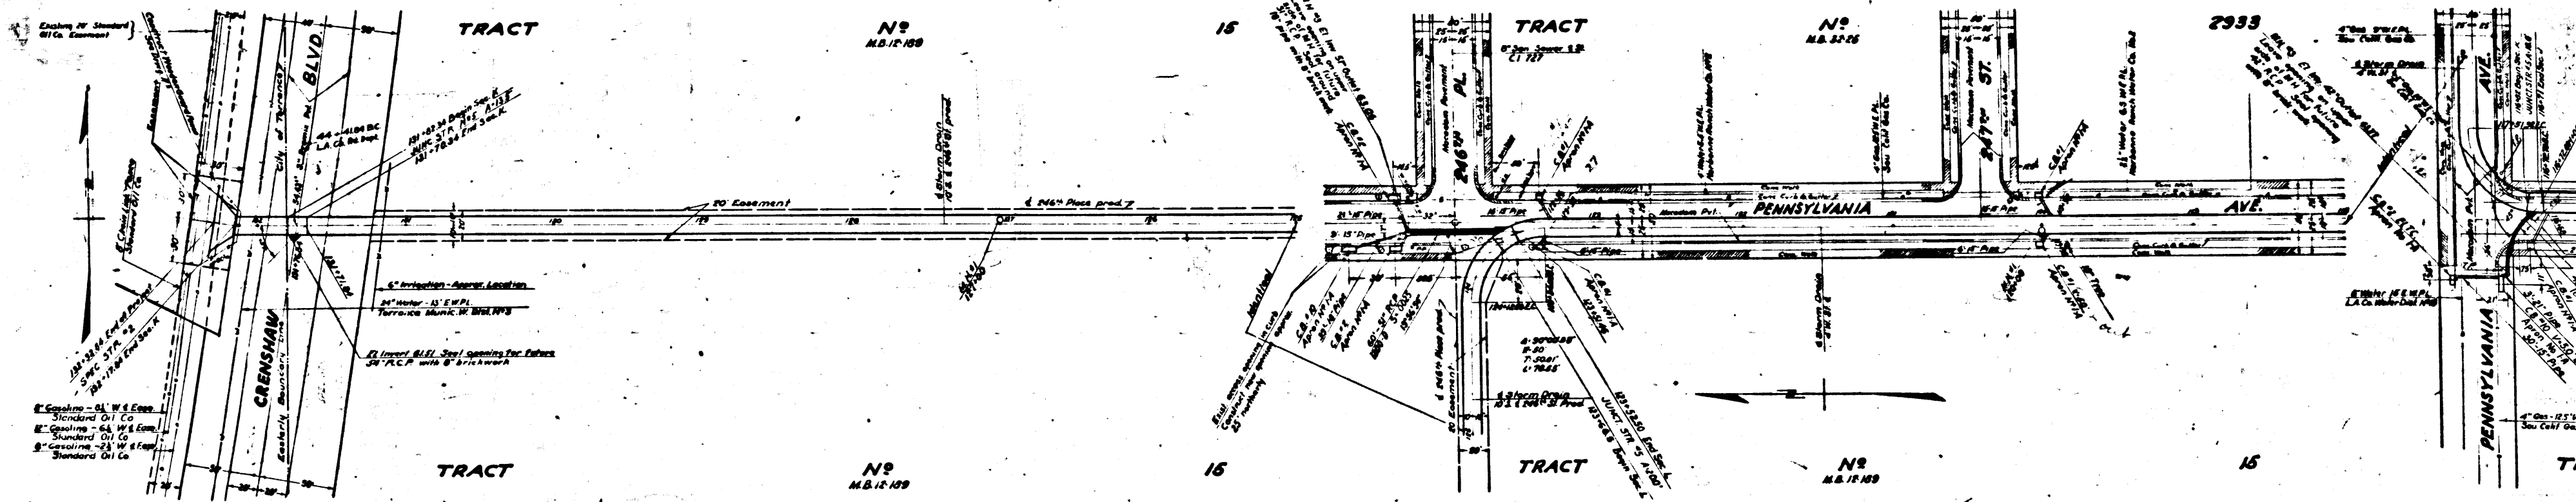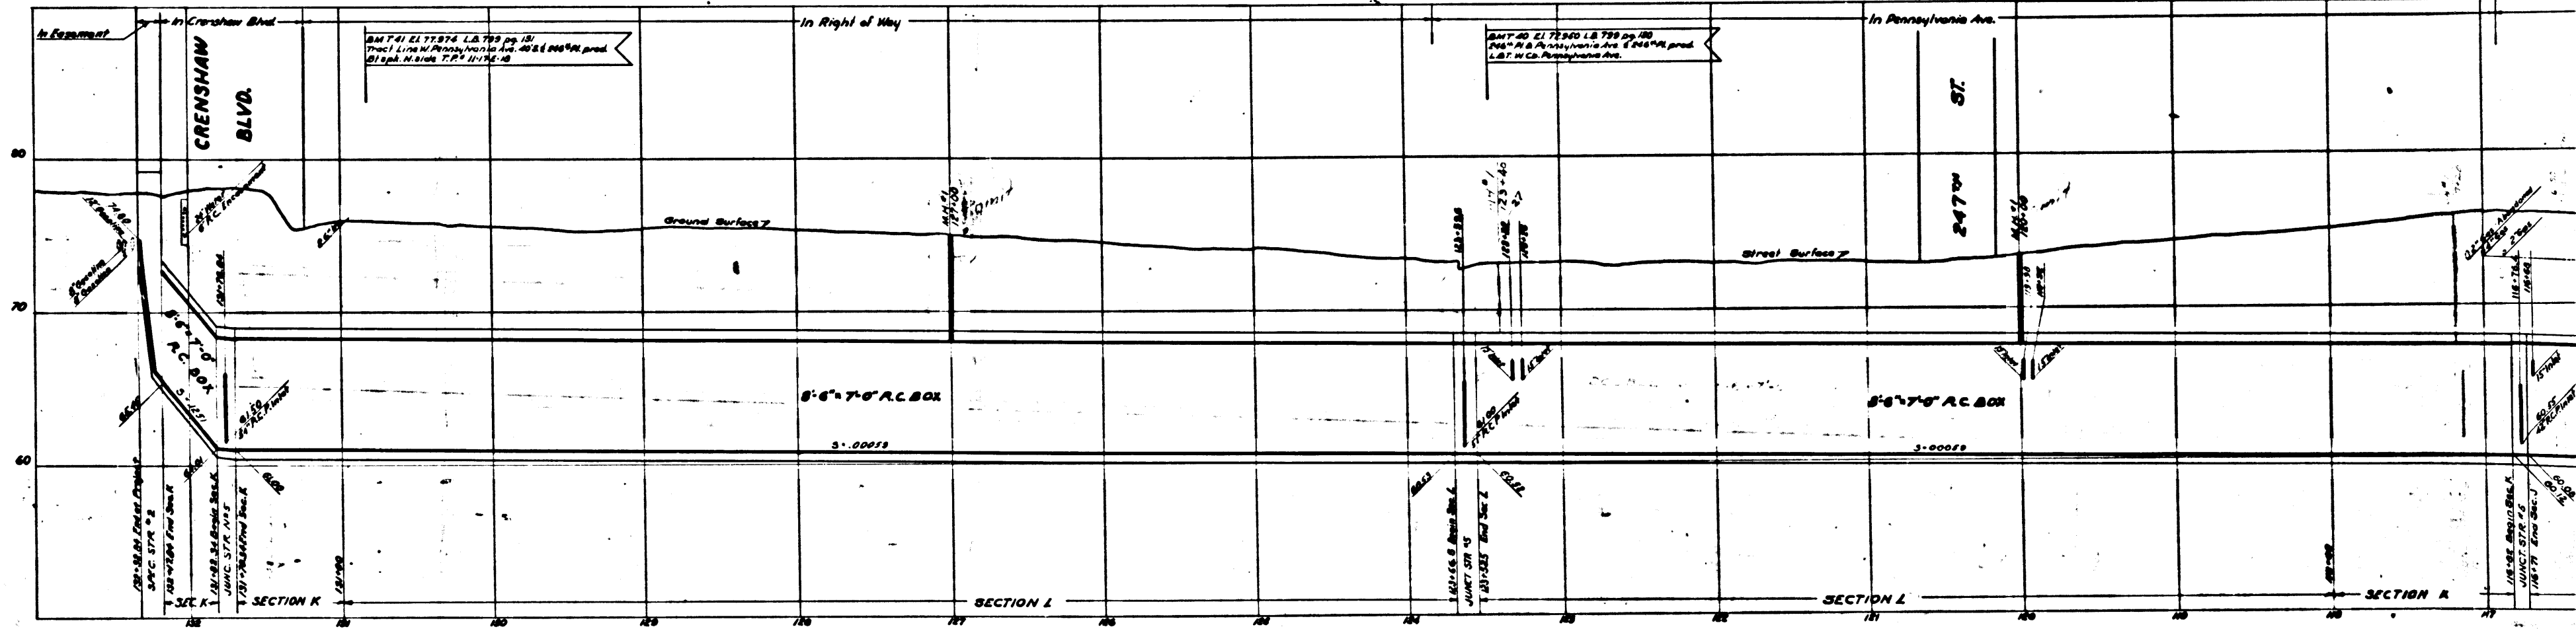

LOMITA

CSB-1165-3A
A3 OF A3